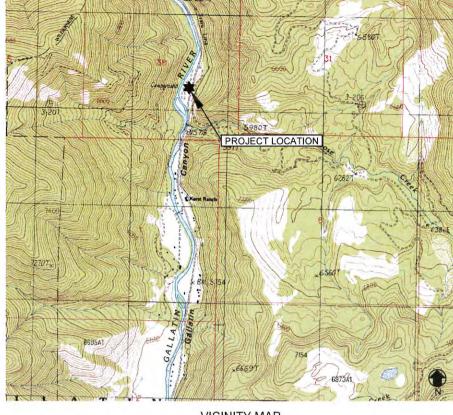
MOOSE CREEK FLAT RIVER ACCESS IMPROVEMENT - PHASE 1

GALLATIN RIVER TASK FORCE JANUARY 2017 RESPEC PROJECT NO. 02870

SHEET INDEX

- **COVER SHEET**
- GENERAL NOTES AND SITE OVERVIEW
- **EXISTING SITE CONDITIONS**
- **OVERVIEW OF PROPOSED TREATMENTS**
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- 13 SEDIMENT/EROSION CONTROL AND REVEGETATION PLAN



VICINITY MAP





REGISTERED PROFESSIONAL ENGINEER

STATE OF MONTANA NO. PEL-PE-LIC-32820

THREE

FORKS



PROJECT LOCATION WEST YELLOWSTONE GALLATIN COUNTY, MONTANA

MANHATTAN

BELGRADE

GENERAL NOTES:

- CONTRACTOR SHALL NOTIFY ALL UTILITY COMPANIES AND DETERMINE LOCATION OF ALL UNDERGROUND UTILITIES BEFORE COMMENCING WORK. CALL 811 (OR ONE CALL UTILITY LOCATE: 1-800-424-5555) A MINIMUM OF 72-HOURS BEFORE WORK IS PLANNED. CONTRACTOR IS RESPONSIBLE FOR PROTECTING AND PROPERLY REPAIRING ANY AND ALL DAMAGED UTILITIES.
- 2. ANY UTILITY LOCATIONS SHOWN ON THE DRAWINGS ARE APPROXIMATE. ALL UTILITY LOCATIONS ARE SUBJECT TO THE ACCURACY OF THE LOCATION METHOD AND SUBJECT TO RELOCATION FROM THE TIME THAT THESE DRAWINGS WERE PREPARED.
- 3. CONTRACTOR SHALL IMMEDIATELY NOTIFY THE ENGINEER OF ANY CONFLICTS FOUND BETWEEN THE CONSTRUCTION PLANS AND CONDITIONS ENCOUNTERED IN THE FIELD.
- 4. CONTRACTOR SHALL, UNLESS OTHERWISE DIRECTED, REPLACE ALL SIGNS, FENCES, CABLES, APPROACH DELINEATORS, OR OTHER FEATURES THAT MAY BE REMOVED TO ACCESS THE CONSTRUCTION AREA. CONTRACTOR SHALL VERIFY THE NATURE AND EXTENT OF ANY OF THESE FEATURES PRIOR TO BIDDING THE WORK. COST OF THIS WORK SHALL BE INCIDENTAL TO THE PROJECT UNLESS OTHERWISE STATED IN THE CONTRACT DOCUMENTS.
- 5. CONTRACTOR SHALL COMPLY WITH ALL CONDITIONS AND RESTRICTIONS FOUND IN REGULATORY PERMITS OBTAINED BY THE ENGINEER/PLANNER.
- 6. LEGAL LOAD LIMIT REQUIREMENTS SHALL BE ADHERED TO ON ALL STATE HIGHWAYS, COUNTY ROADS, AND CITY STREETS.
- 7. THE CONTRACTOR IS TO PROVIDE HIS OWN WATER FOR COMPACTION AND DUST ABATEMENT.
- 8. CONSTRUCTION SHALL COMPLY WITH THESE PLANS IN ADDITION TO THE CONTRACT DOCUMENTS AND SPECIFICATIONS.
- 9. QUANTITY ESTIMATES PROVIDED FOR GUIDANCE PURPOSES AND SHOULD NOT BE USED TO BASE PRICING.
- 10. ALL NEW RIPRAP TO CONFORM TO MONTANA DEPARTMENT OF TRANSPORTATION 701.06 CLASS II RANDOM RIPRAP. ALL IMPORTED RIPRAP TO BE OBTAINED AT USFS CASCADE QUARRY PIT LOCATED BETWEEN MILE MARKERS 60 AND 61 OF US HIGHWAY 191, FURNISHED BY THE USFS AT NO COST TO CONTRACTOR. RIPRAP MUST BE SORTED TO CONFORM TO SPECIFICATIONS, LOADED AND HAULED TO SITE, AND PLACED ACCORDING TO THE DRAWINGS AT THE EXPENSE OF THE CONTRACTOR.
- 11. APPROXIMATELY 315 CY OF EXCAVATION AND GRADING ARE ESTIMATED FOR BOAT RAMP AND SLAB ROCK KAYAK LAUNCH. APPROXIMATELY 30 CY OF EXCAVATED MATERIAL MAY BE USED AS EMBANKMENT FILL FOR ROCK TERRACE RIVER ACCESS.
- 12. APPROXIMATELY 285 CY OF EXCAVATED MATERIAL TO BE HAULED TO USFS CASCADE QUARRY PIT LOCATED BETWEEN MILE MARKERS 60 AND 61 OF US HIGHWAY 191 AND SORTED INTO TWO STOCKPILES SUITABLE FINES AND UNSUITABLE COARSE/COBBLE.
- 13. DEWATERING ACTIVITIES MAY BE REQUIRED FOR CONSTRUCTION. CONSTRUCTION CONTRACTOR IS RESPONSIBLE FOR OBTAINING A UNITED STATED ARMY CORPS OF ENGINEERS NATIONWIDE PERMIT 33 TEMPORARY CONSTRUCTION, ACCESS AND DEWATERING PERMIT, ALONG WITH ANY OTHER RELEVANT PERMITS REQUIRED FOR CONSTRUCTION DEWATERING.



ME: ZARESPECIO2870 - GALLATIN RIVER ACCESS SITESICADISHEFTSIO2605 S. COVER. PJ DWG

JRCES FHONE (406) 284-2525

RESPEC 38
SOURCES NATURAL RESOURCES PH
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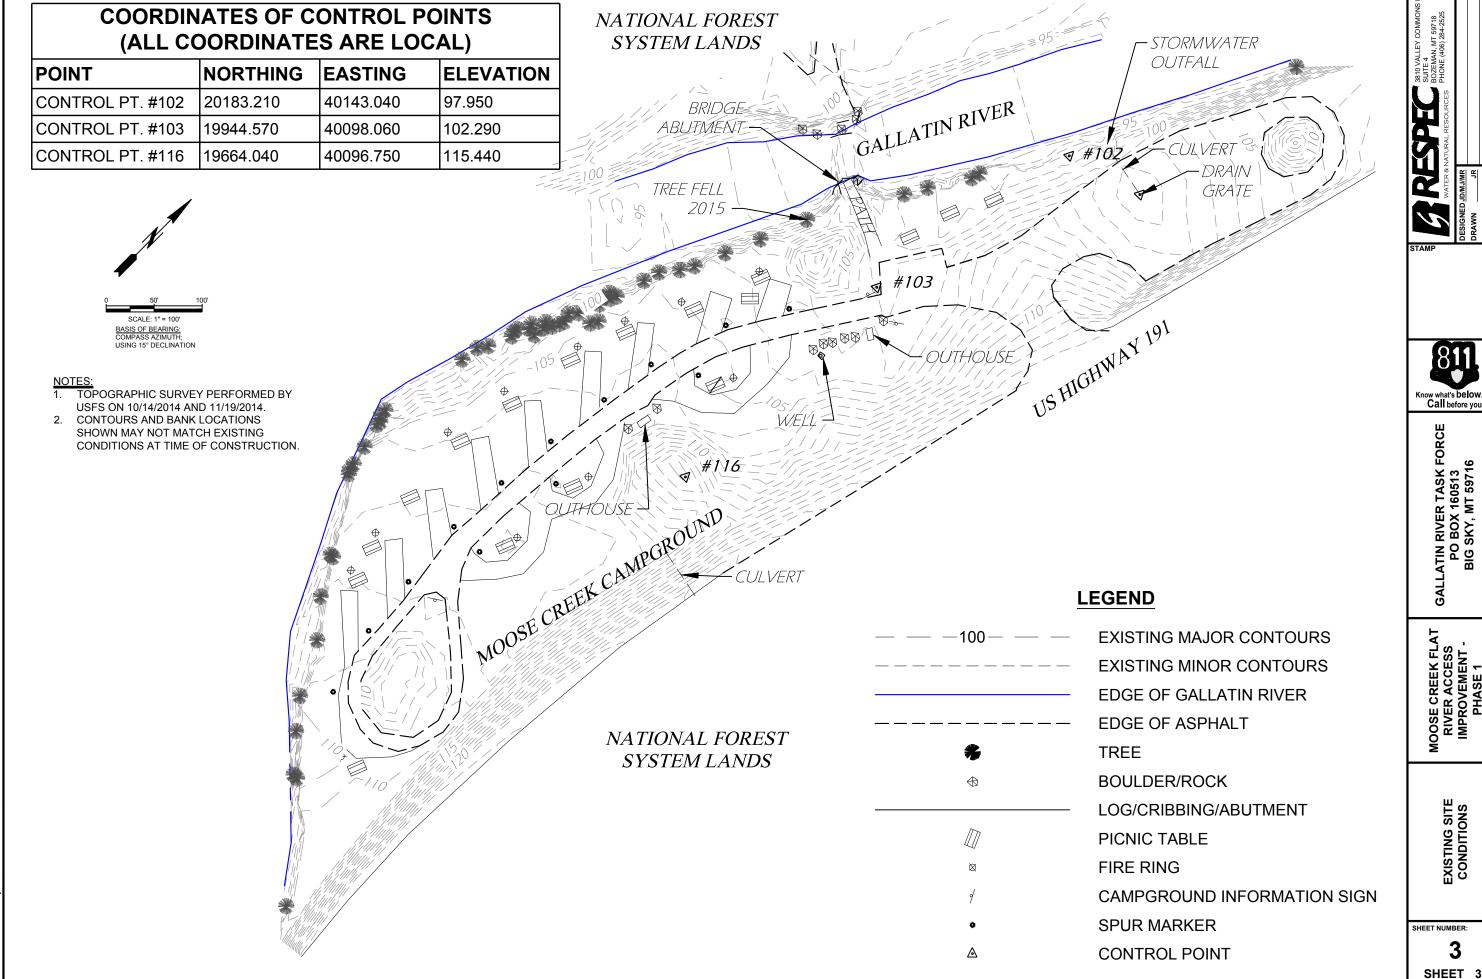
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GALLATIN RIVER TASK FORCE PO BOX 160513 BIG SKY, MT 59716

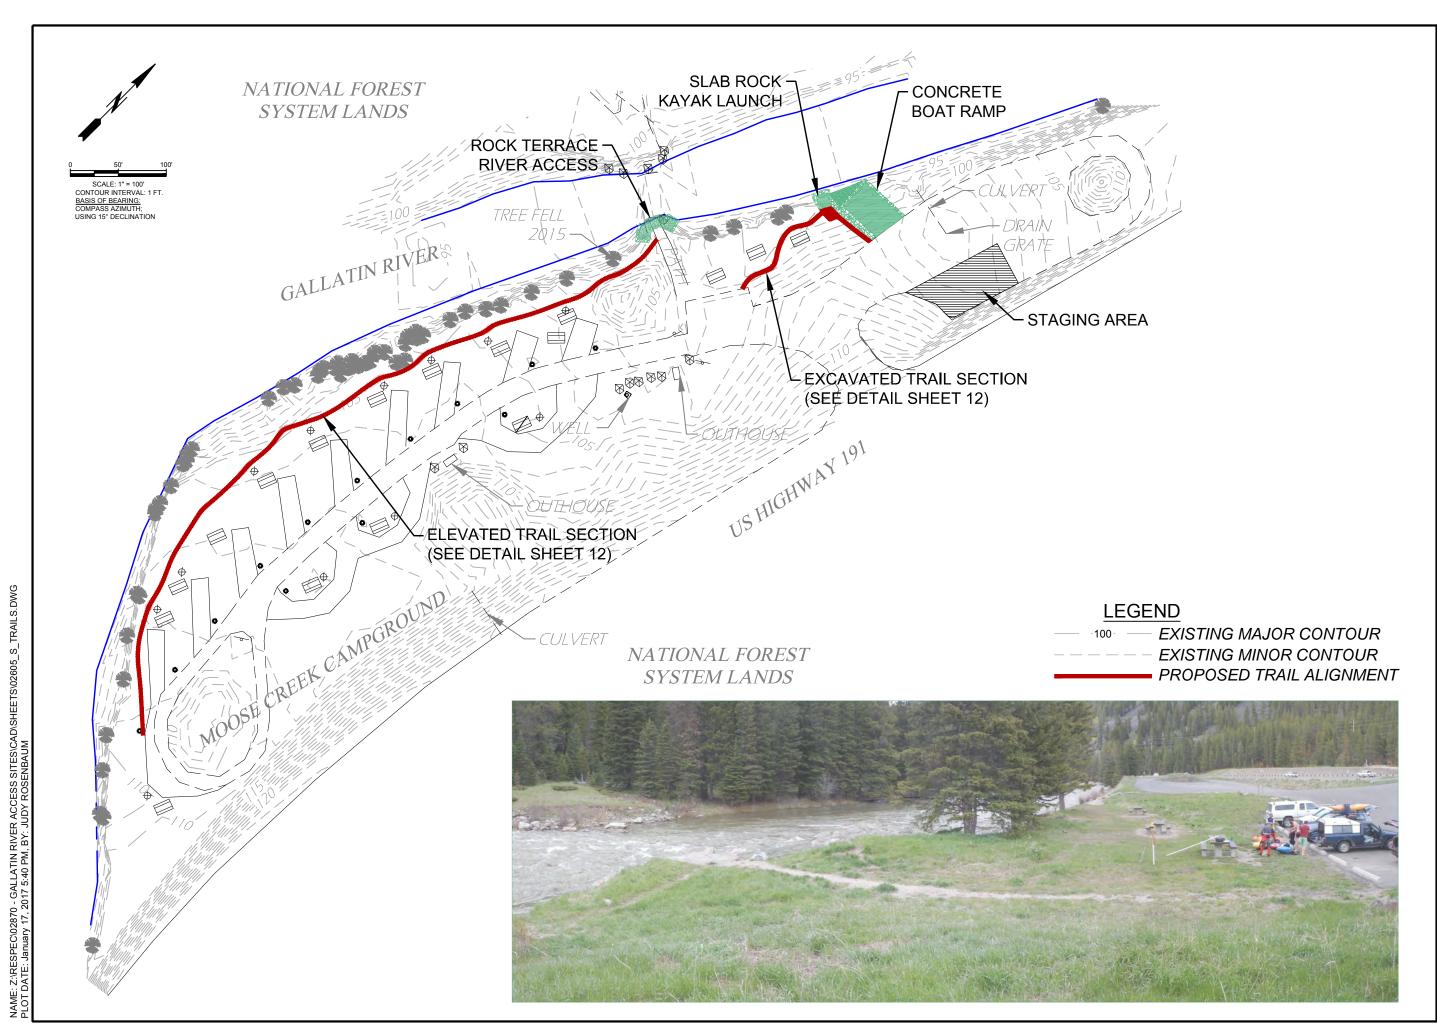
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SENERAL NOTES AND SITE OVERVIEW

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3810 VALLEY COMMO SUITE 4 SUITE 4 SUITE 4 SUITE 8 SUITE 4 SUITE 8018 818 8 8 NATURAL RESOURCES PHONE (406) 284-2525 PHONE (406) 284-2525 R

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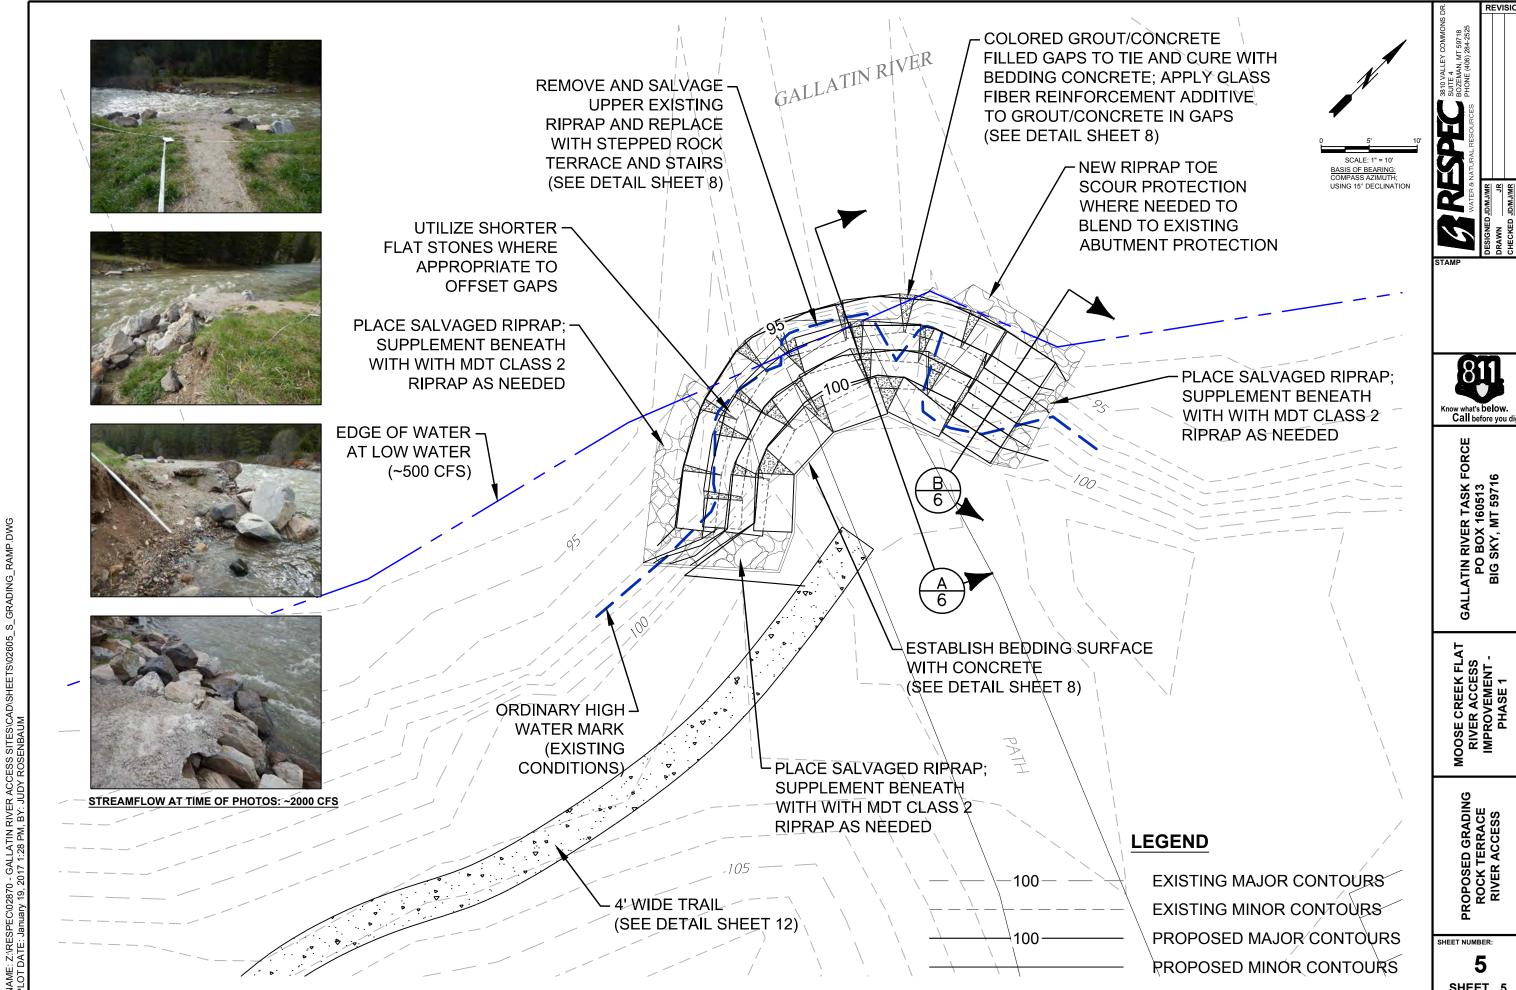
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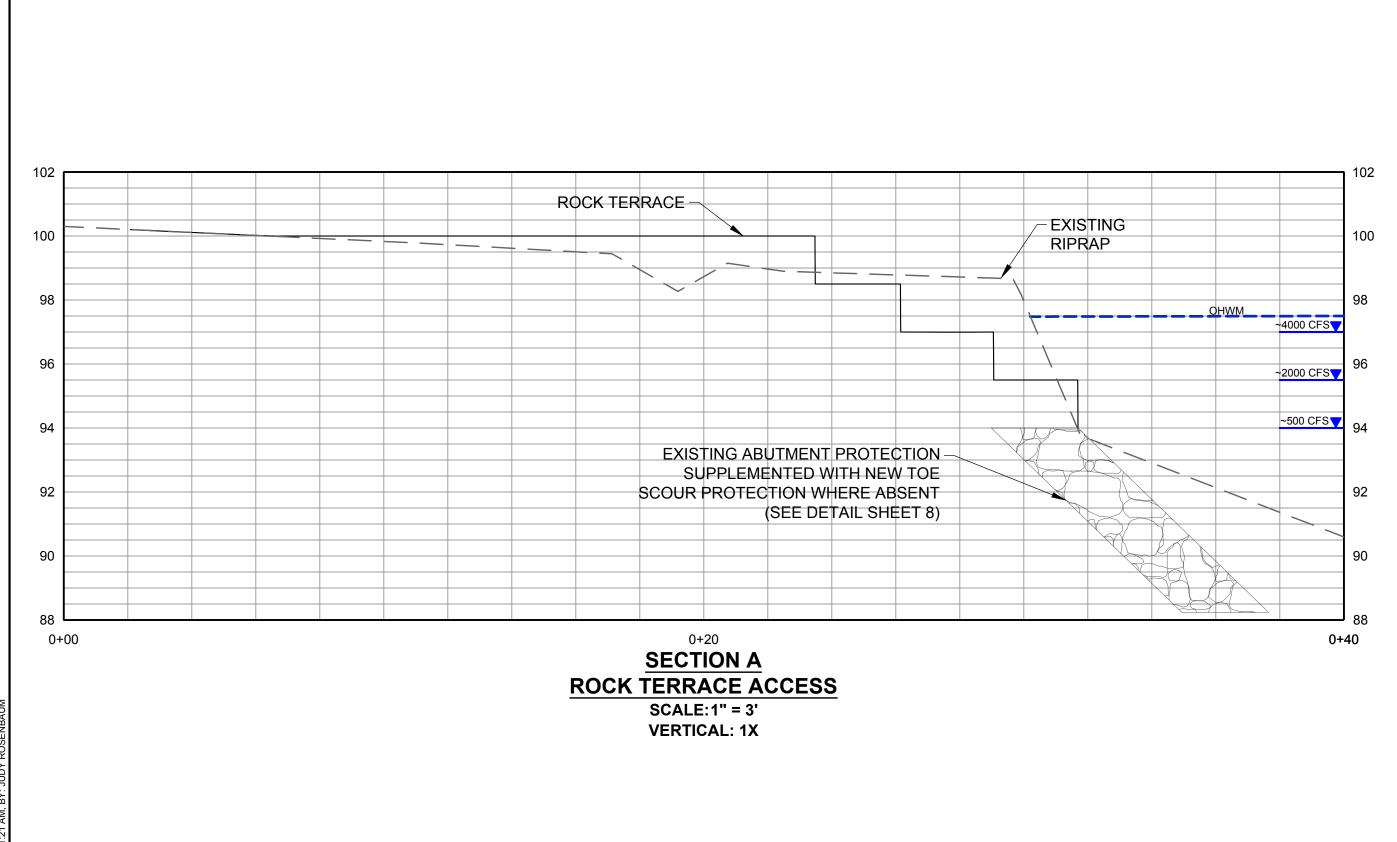
RIVER ACCESS
IMPROVEMENT -

OVERVIEW OF PROPOSED TREATMENTS

SHEET NUMBER:



5



NAME: Z.'RESPEC'02870 - GALLATIN RIVER ACCESS SITES\CAD\SHEETS\02605_S_GRADING_RAMP.DWG PLOT DATE: January 12, 2017 11:21 AM, BY: JUDY ROSENBAUM

MOOSE CREEK FLAT RIVER ACCESS IMPROVEMENT -PHASE 1

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ROCK TERRACE RIVER ACCESS PROFILE

SHEET NUMBER:

6

ROCK STAIR ACCESS

SCALE:1" = 3' **VERTICAL: 1X**

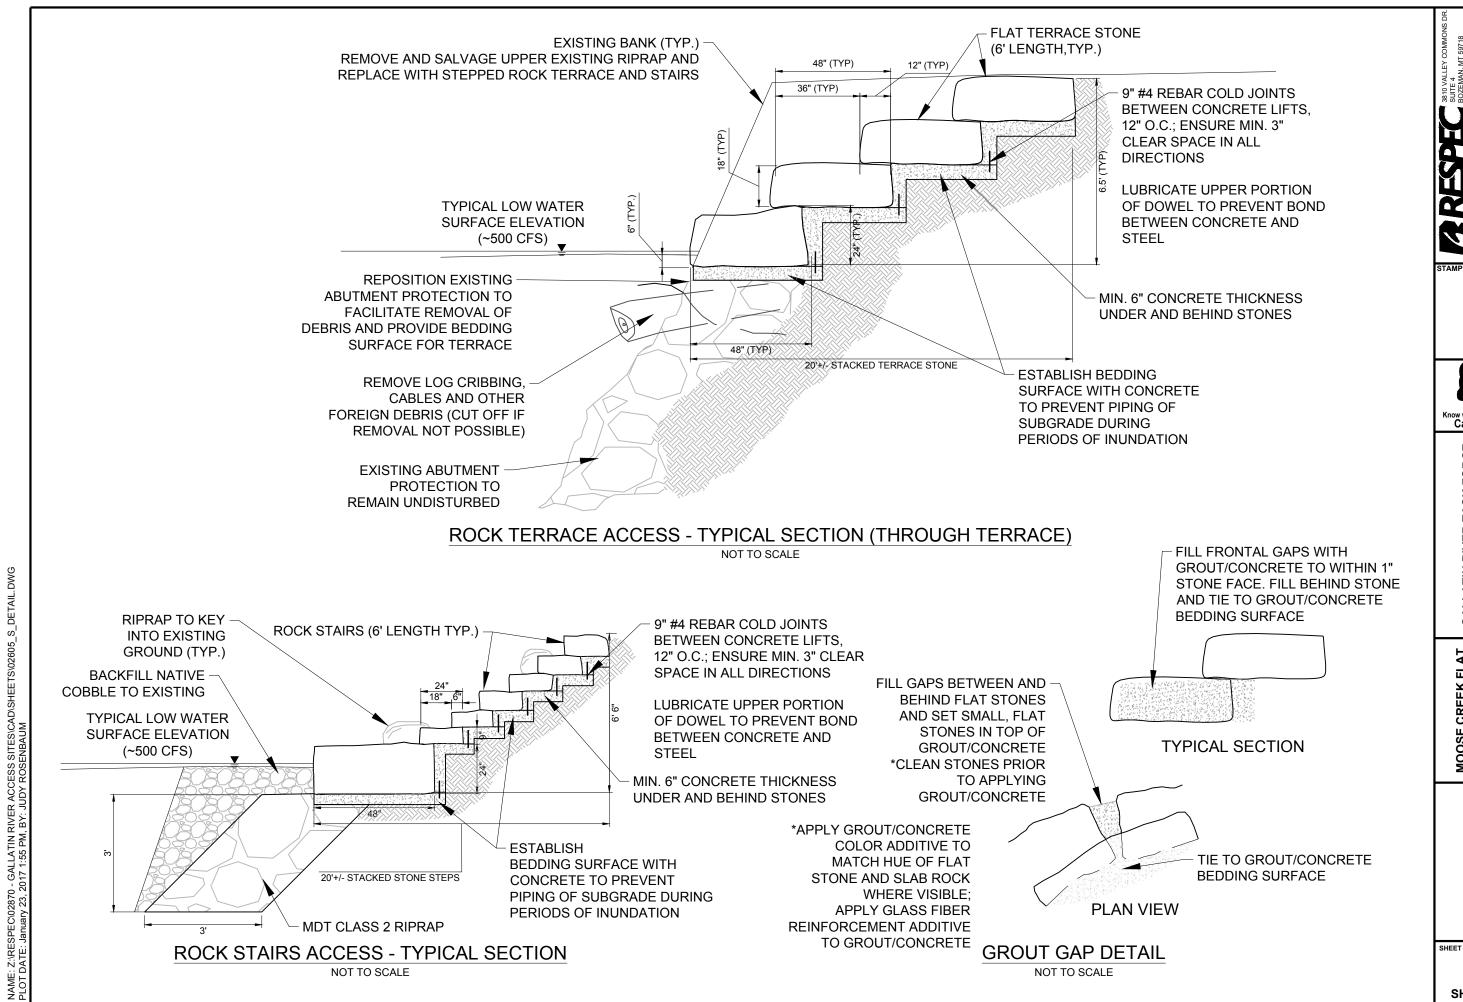
SUMMARY OF QUANTITIES				
ROCK TERRACE AND STAIR ACCESS	LOWER TIER (6x4x2)	7	EA	
	LOWER TIER (3x4x2)	2	EA	
	2ND TIER (6x4x1.5)	5	EA	
	2ND TIER (3x4x1.5)	2	EA	
	3RD TIER (6x4x1.5)	4	EA	
	3RD TIER (3x4x1.5)	2	EA	
la.	TOP TIER (6x4x1.5)	4	EA	
	STAIRS (6x2x0.75)	5	EA	
	CONCRETE BEDDING AND GAPS	41	CUYD	
	RIPRAP REMOVAL (94.0 - TOP OF RIPRAP)	100	CUYD	
	TERRACE FILL (SALVAGE FROM BOAT RAMP EXCAVATION)	30	CUYD	

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3810 VALLEY COMMOI SUITE 4 BOZEMAN, MT 59718 NATURAI RESOURCES PHONE (406) 284-2525

SHEET NUMBER:



RESOURCES PHONE (406) 284-2525
GE IN BEDDING SURFACE DETAIL

WATER & NATURAL RESOURCES

JOMUNIN #1: CHANGE IN BEDDI

JR

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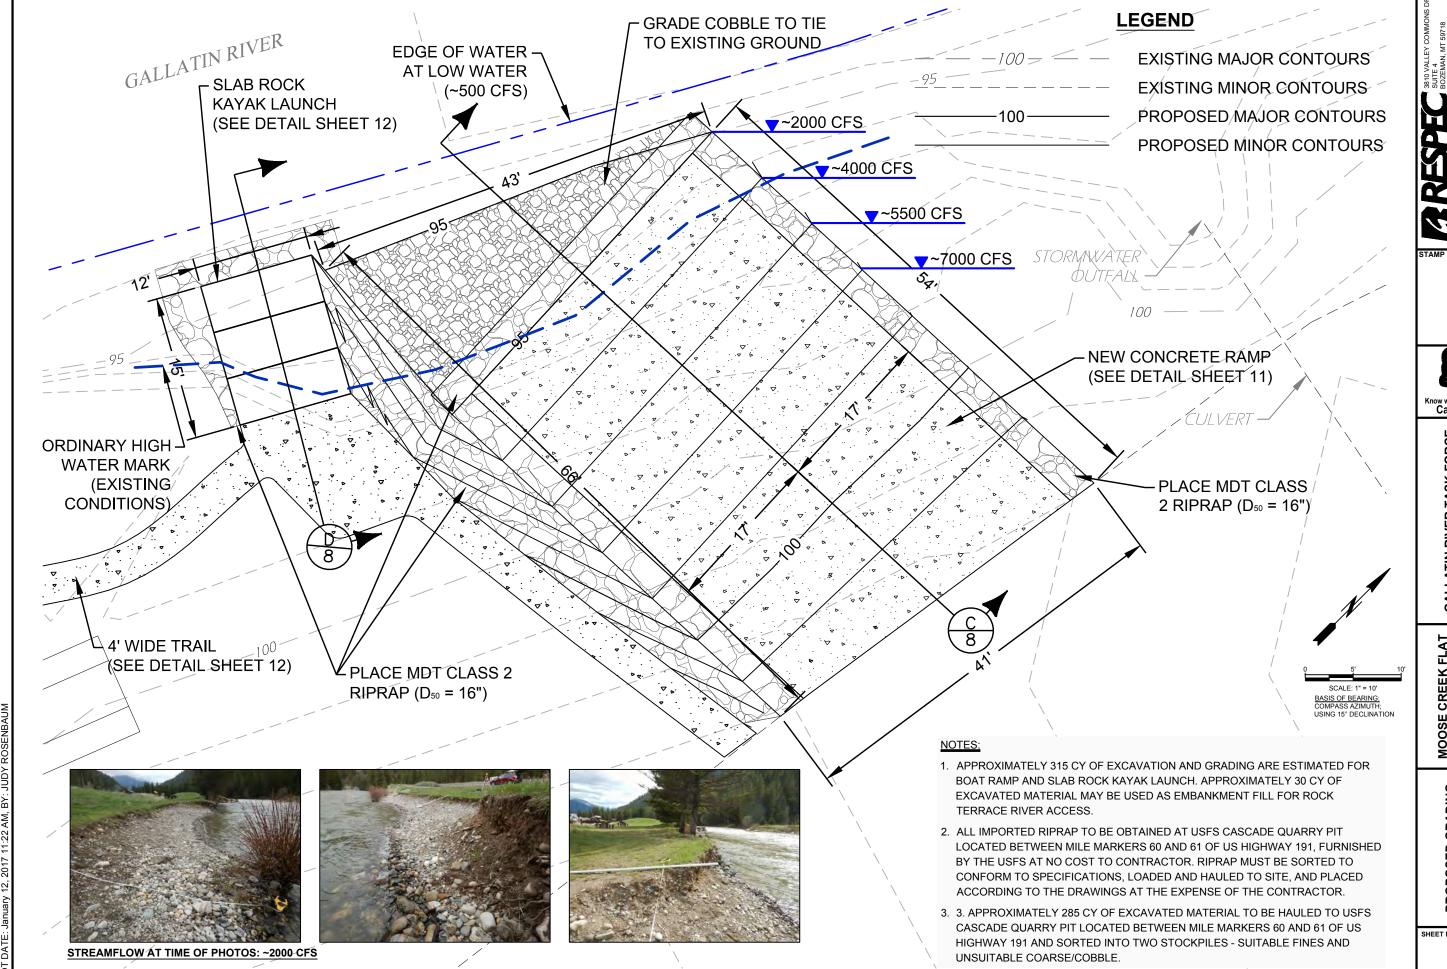
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MOOSE CREEK FLAT RIVER ACCESS IMPROVEMENT -PHASE 1

ROCK TERRACE AND STAIRS DETAILS

SHEET NUMBER:



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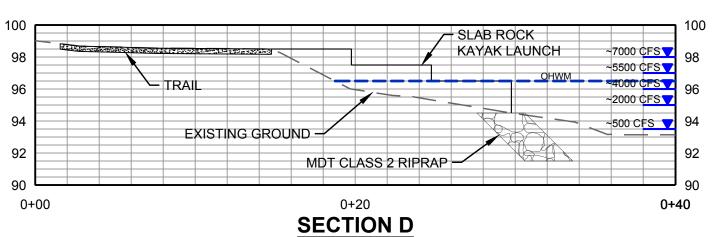
PROPOSED GRADING BOAT RAMP AND KAYAK LAUNCH

SHEET NUMBER:

9

BOAT RAMP

SCALE:1" = 6' VERTICAL: 1X



KAYAK LAUNCH

SCALE:1" = 6' **VERTICAL: 1X**

SUMMARY OF QUANTITIES				
BOAT RAMP AND KAYAK LAUNCH		PROJECT TOTAL UNIT		
	SURFACE AREA (BOAT RAMP)	1710	SQFT	
	CONCRETE, RAMP (INCL. REINFORCEMENT MATERIALS, AND CONTRACTION/EXPANSION JOINTS)	39	CUYD	
	FILTER FABRIC	1030	SQFT	
	BEDDING MATERIAL	23	CUYD	
	LOWER TIER (6x4x2.5)	3	EA	
	MIDDLE TIER (6x4x1)	3	EA	
	TOP TIER (5x4x1)	3	EA	
	CONCRETE BEDDING (KAYAK LAUNCH)	2	CUYD	
	CLASS 2 RIPRAP (OBTAIN FROM CASCADE PIT: SORT, LOAD, HAUL AND PLACE)	94	CUYD	
	EXCAVATE	315	CUYD	

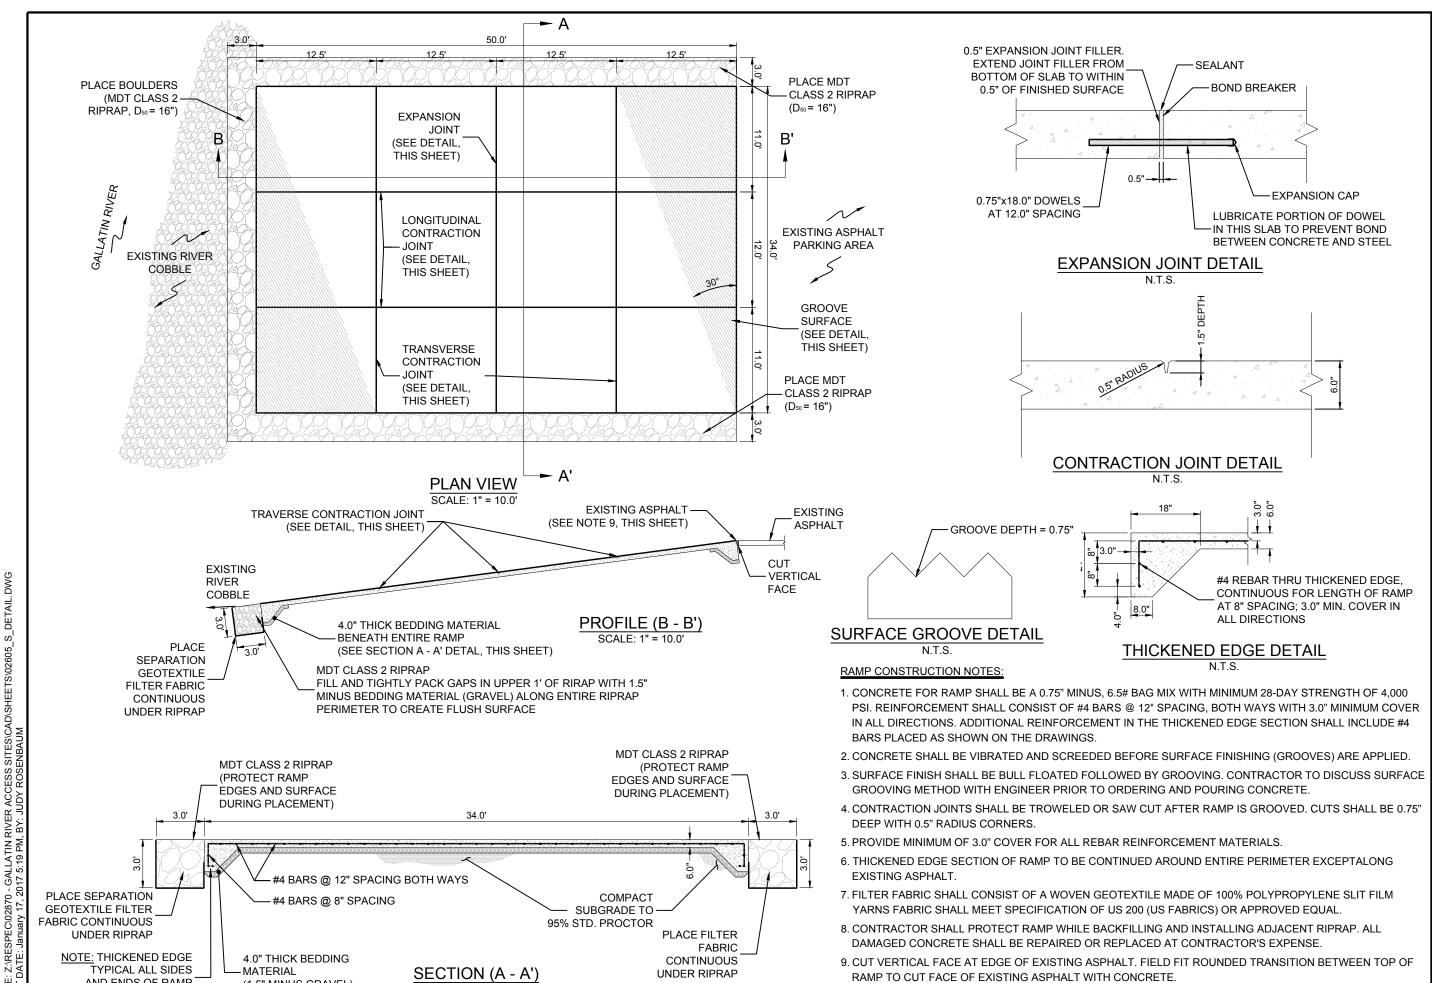
MOOSE CREEK FLAT RIVER ACCESS IMPROVEMENT -PHASE 1

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SUITE 4
SUITE 4
SUITE 4
BOZEMAN, MT 59718
ANTE 8, NATH DAIL DESCRIPCES
PHONE (406) 284-2525

SHEET NUMBER: 10



AND ENDS OF RAMP

(SEE DETAIL, THIS SHEET)

(1.5" MINUS GRAVEL)

SCALE: 1" = 6.0'

RAMP TO CUT FACE OF EXISTING ASPHALT WITH CONCRETE.

10. SEAL FINISHED RAMP WITH NON-TOXIC, ECO-SAFE CONCRETE SEALER APPROVED BY THE ENGINEER.

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MOOSE CREEK FLAT RIVER ACCESS IMPROVEMENT -PHASE 1

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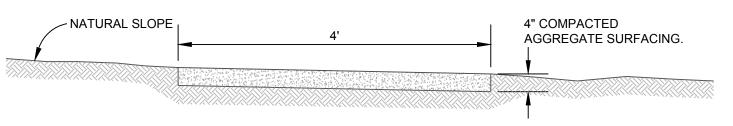
TRAIL CONSTRUCTION NOTES:

- 1. TRAIL AGGREGATE SURFACE COURSE TO CONFORM TO FHWA FP03 703.05, ELEVATED TRAIL SECTION UNDERLAIN BY SEPARATION GEOTEXTILE.
- 2. NO EXCAVATION PERMITTED FOR ELEVATED TRAIL CONSTRUCTION.
- 3. USE SALVAGED TOPSOIL FROM EXCAVATED TRAIL SECTION AND BOAT RAMP EXCAVATION FOR ELEVATED TRAIL SECTION SHOULDER.

GRADATION EXTRACTED FROM TABLE 703-2 OF FP03 TARGET VALUE RANGES FOR TRAIL BASE GRADATION PERCENT BY MASS PASSING DESIGNATED SIEVE (AASHTO T 27 AND T 11)

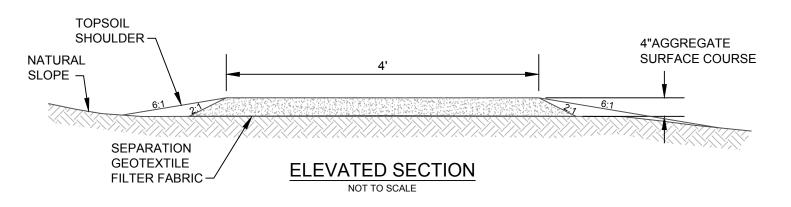
D (BASE)		
100 (1)		
86 – 100 ⁽⁶⁾		
51 – 82 ⁽⁶⁾		
36 – 64 ⁽⁶⁾		
12 – 26 ⁽⁴⁾		
4.0 – 7.0 ⁽³⁾		

- STATISTICAL PROCEDURES DO NOT APPLY.
- () THE VALUE IN THE PARENTHESES IS THE ALLOWABLE DEVIATION (±) FROM THE TARGET VALUES...



EXCAVATED SECTION

NOT TO SCALE



JMMARY OF QUANTITIES		
COMPACTED AGGREGATE SURFACE	11	CUYD
COMPACTED AGGREGATE SURFACE	47	CUYD
SEPARATION GEOTEXTILE FILTER FABRIC	4340	SQFT
	COMPACTED AGGREGATE SURFACE COMPACTED AGGREGATE SURFACE	COMPACTED AGGREGATE SURFACE 11 COMPACTED AGGREGATE SURFACE 47

SUTURE SU

on

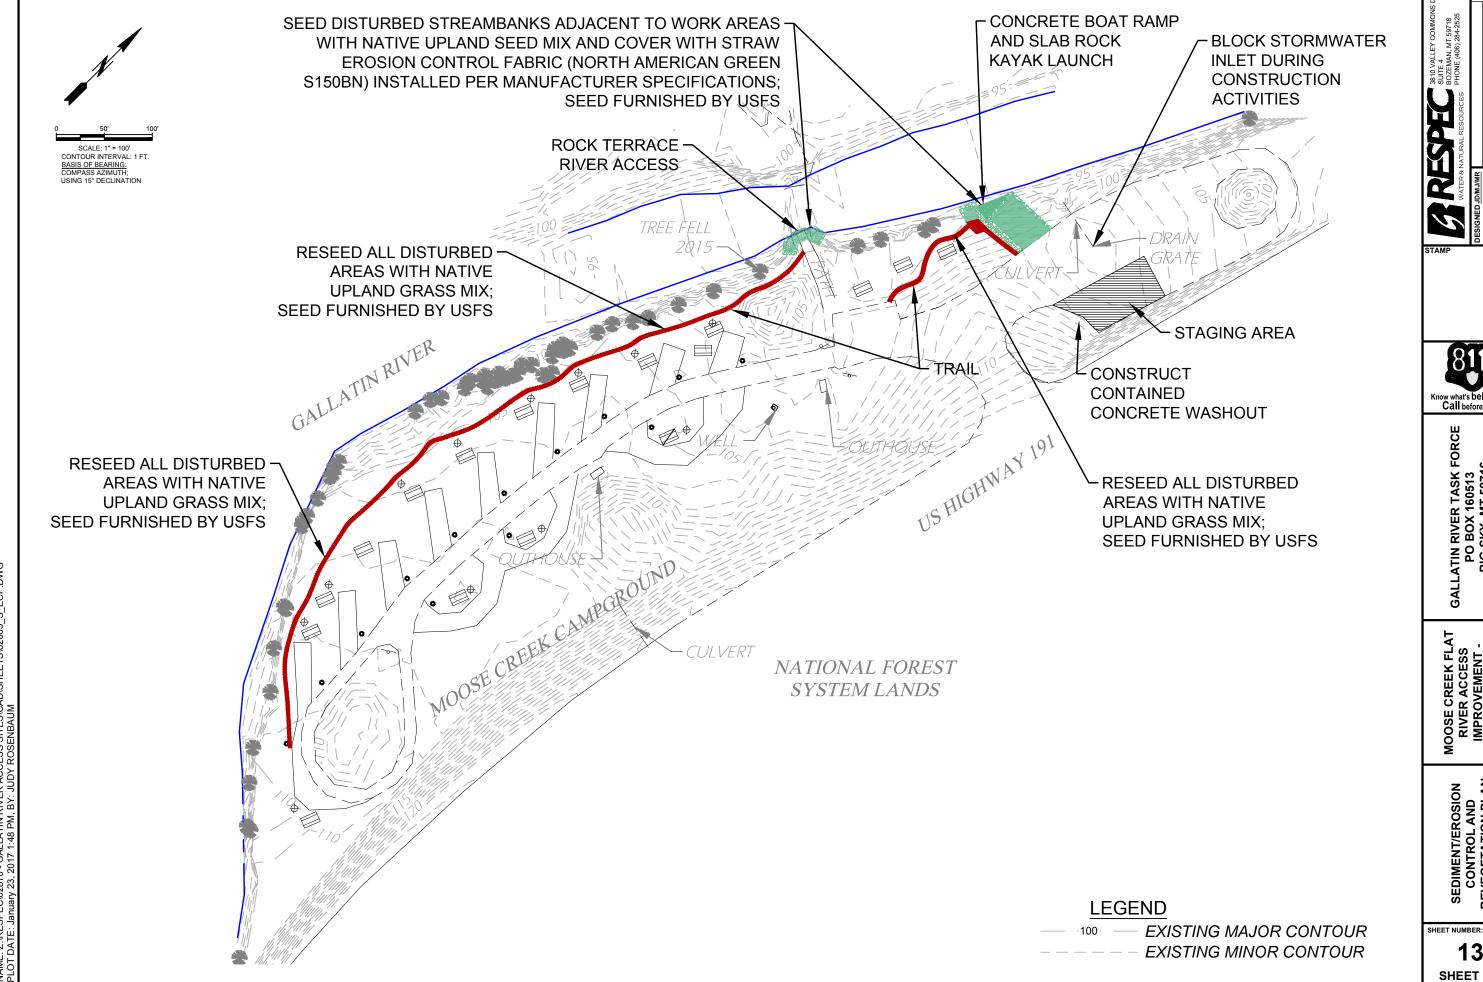
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MOOSE CREEK FLAT RIVER ACCESS IMPROVEMENT -PHASE 1

> KAYAK LAUNCH AND TRAIL DETAILS

SHEET NUMBER:



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